

A

B

C


D

E

F


G

H

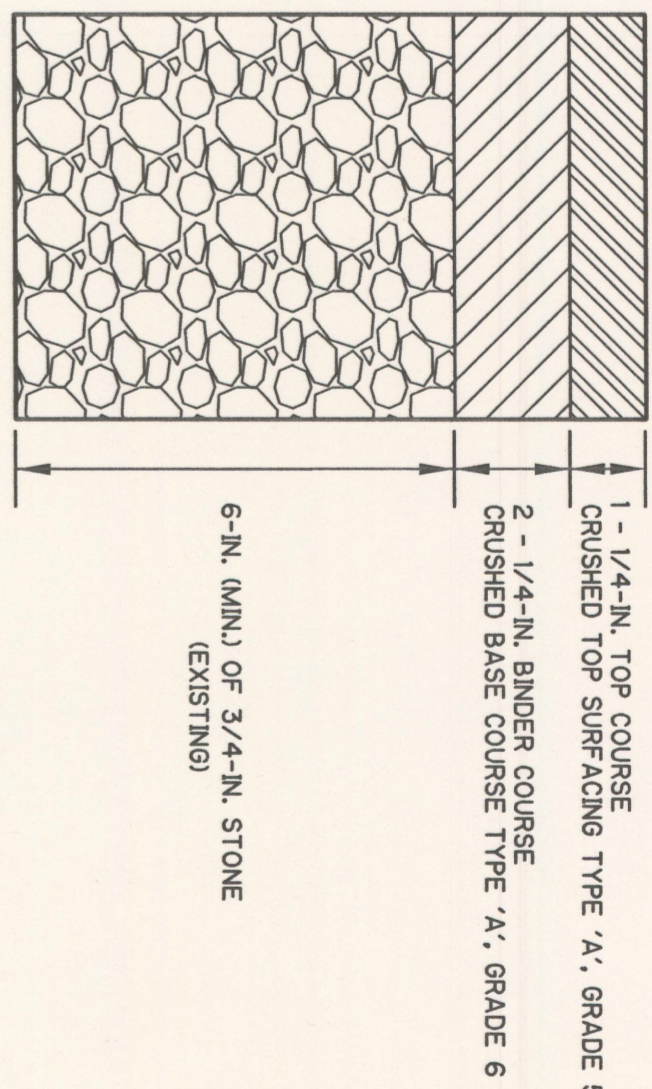


BUILDING NO. 1 - ASPHALT FLOOR CROSS SECTION
NOT TO SCALE

- NOTES:
- DIMENSIONS AND DETAILS ARE APPROXIMATE AND WERE OBTAINED FROM ROUGH FIELD MEASUREMENTS TO CONVEY THE GENERAL INTENT OF THE WORK.
 - THIS PLAN DEPICTS THE FLOOR IMPROVEMENT PLANS AT THE SITE. THIS PLAN DOES NOT DEPICT THEIR LOCATION RELATIVE TO EACH OTHER. REFER TO THE SITE PLAN (C-1) FOR ORIENTATION ON THE SITE.
 - ASPHALT PAVING TO CONSIST OF 2 - 1/4" BINDER COURSE, WITH A 1 - 1/4" TOP COURSE. BINDER COURSE SHALL CONSIST OF CRUSHED BASE COURSE TYPE 'A', GRADE 6 AS DEFINED IN STANDARD SPECIFICATIONS FOR ROAD AND BRIDGE CONSTRUCTION (SSBRC) AS ADOPTED BY THE MONTANA DEPARTMENT OF TRANSPORTATION AND THE MONTANA TRANSPORTATION COMMISSION. TOP COURSE SHALL CONSIST OF CRUSHED TOP SURFACING TYPE 'A', GRADE 5 AS DEFINED IN SSBRC. BINDER COURSE SHALL CONSIST OF CRUSHED TOP SURFACING TYPE 'A', GRADE 6 AS DEFINED IN SSBRC. WATER SERVICE SHALL BE 6-IN. DIA. WATER SERVICE SHALL BE 6-IN. DIA. WATER SERVICE SHALL BE 6-IN. DIA. ALL ASPHALT PAVED AREAS SHALL CONSIST OF A 6-IN. LAYER OF 3/4-IN. STONE.

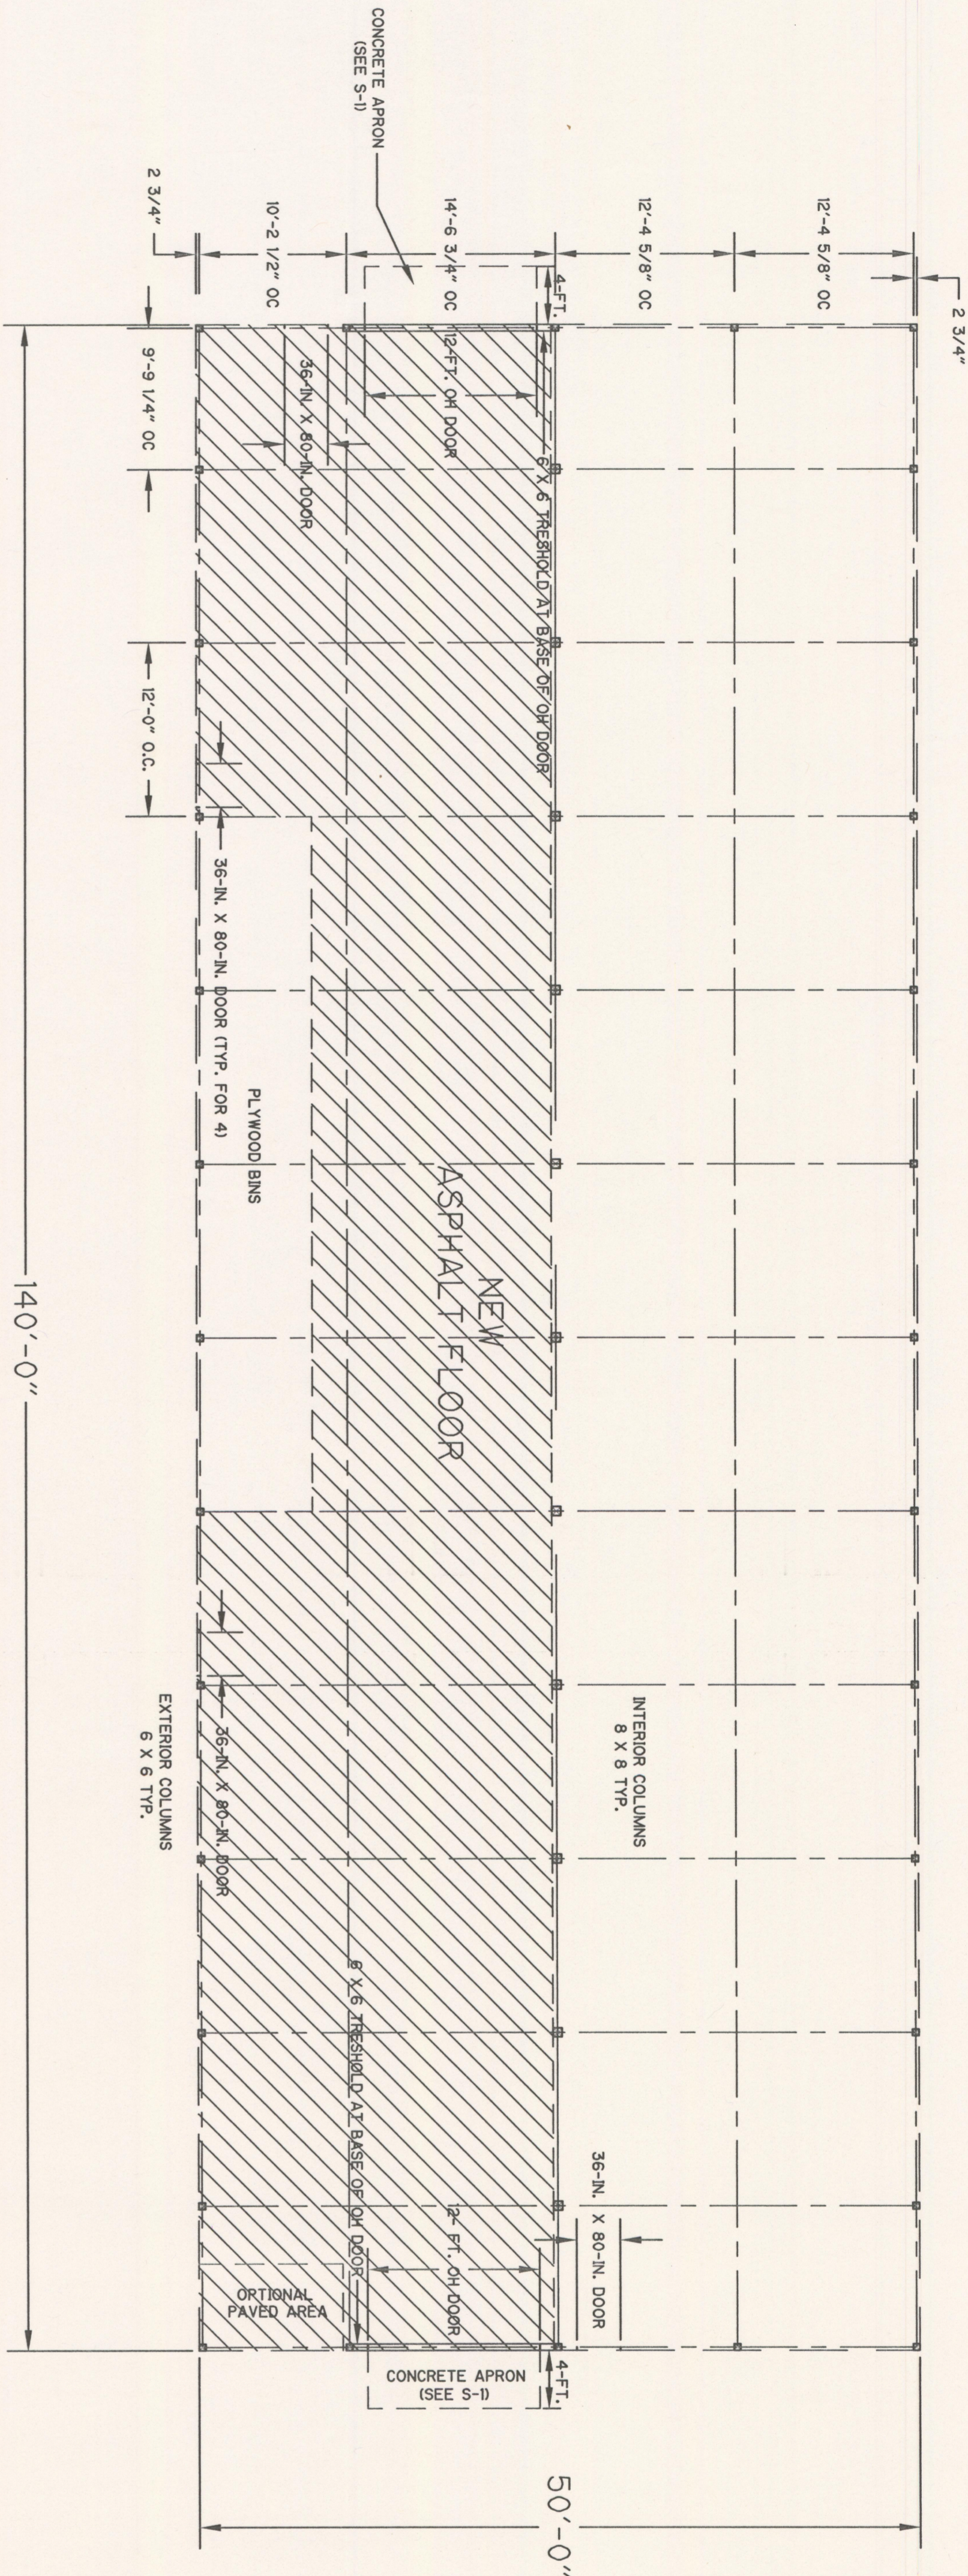



BUILDING #1
SCALE: 1/8" = 1'-0"

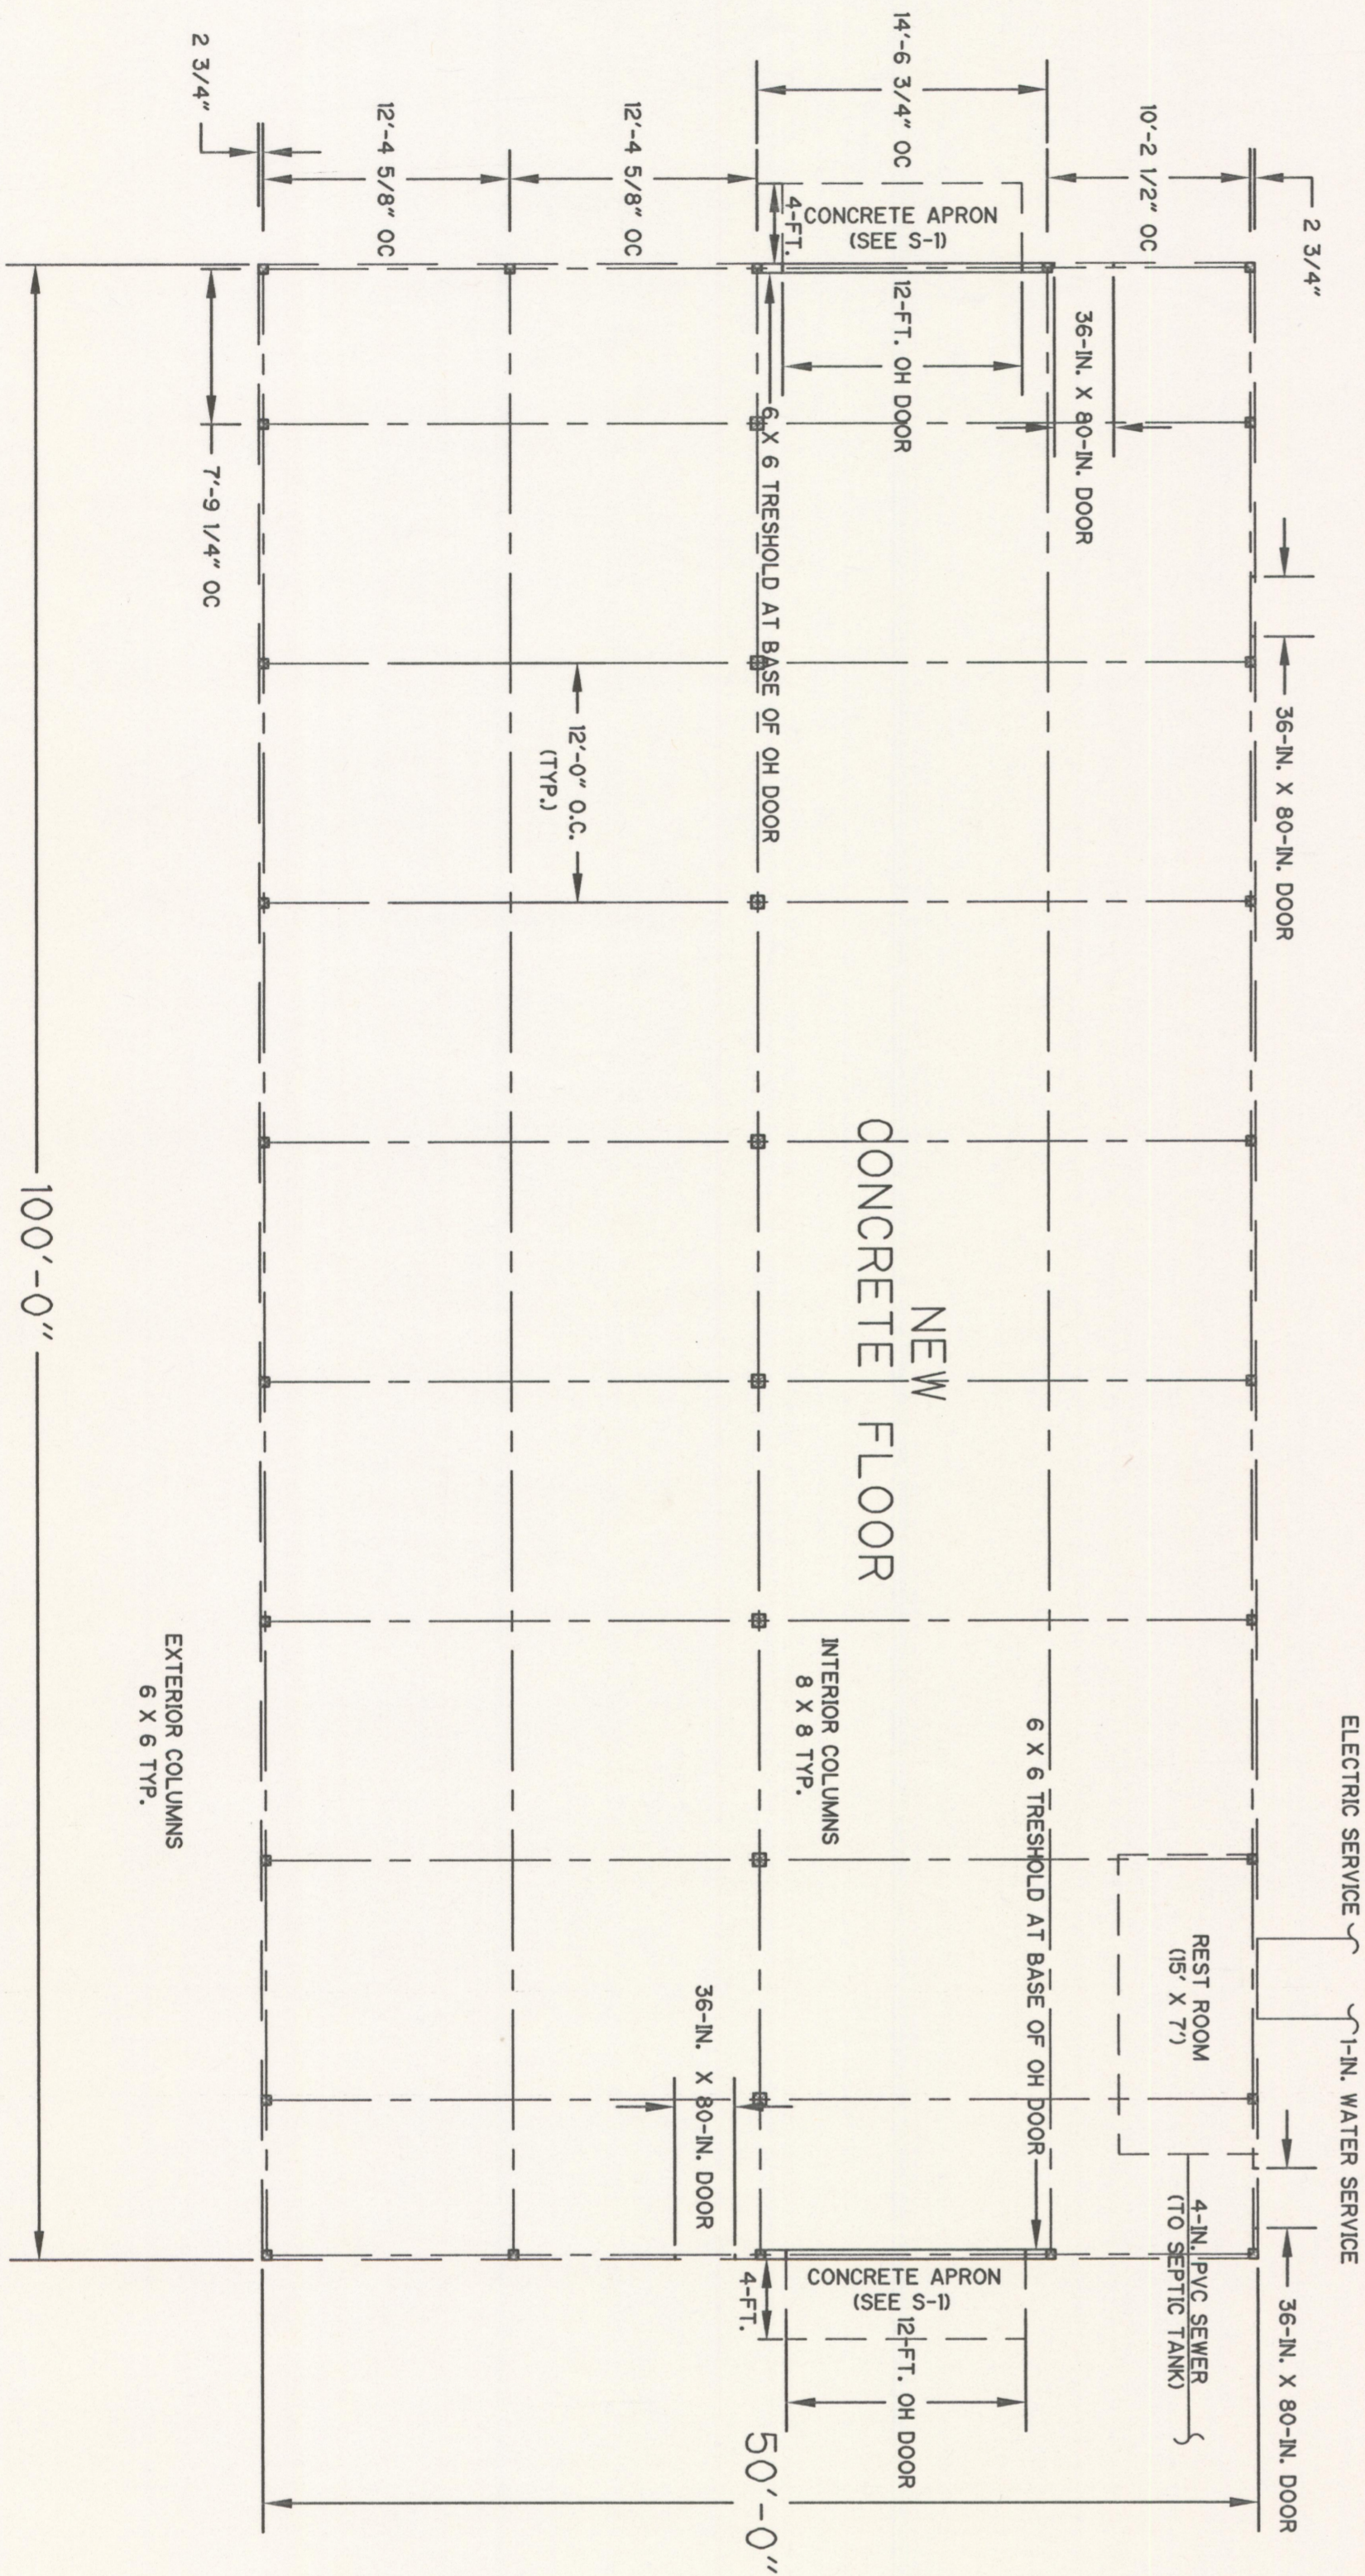

BUILDING #2
SCALE: 1/8" = 1'-0"

3/4-IN. CRUSHED STONE
BEDDING FOR SEPTIC TANK

PROPOSED PUMP/SEPTIC TANK COMBINATION DETAIL
NOT TO SCALE

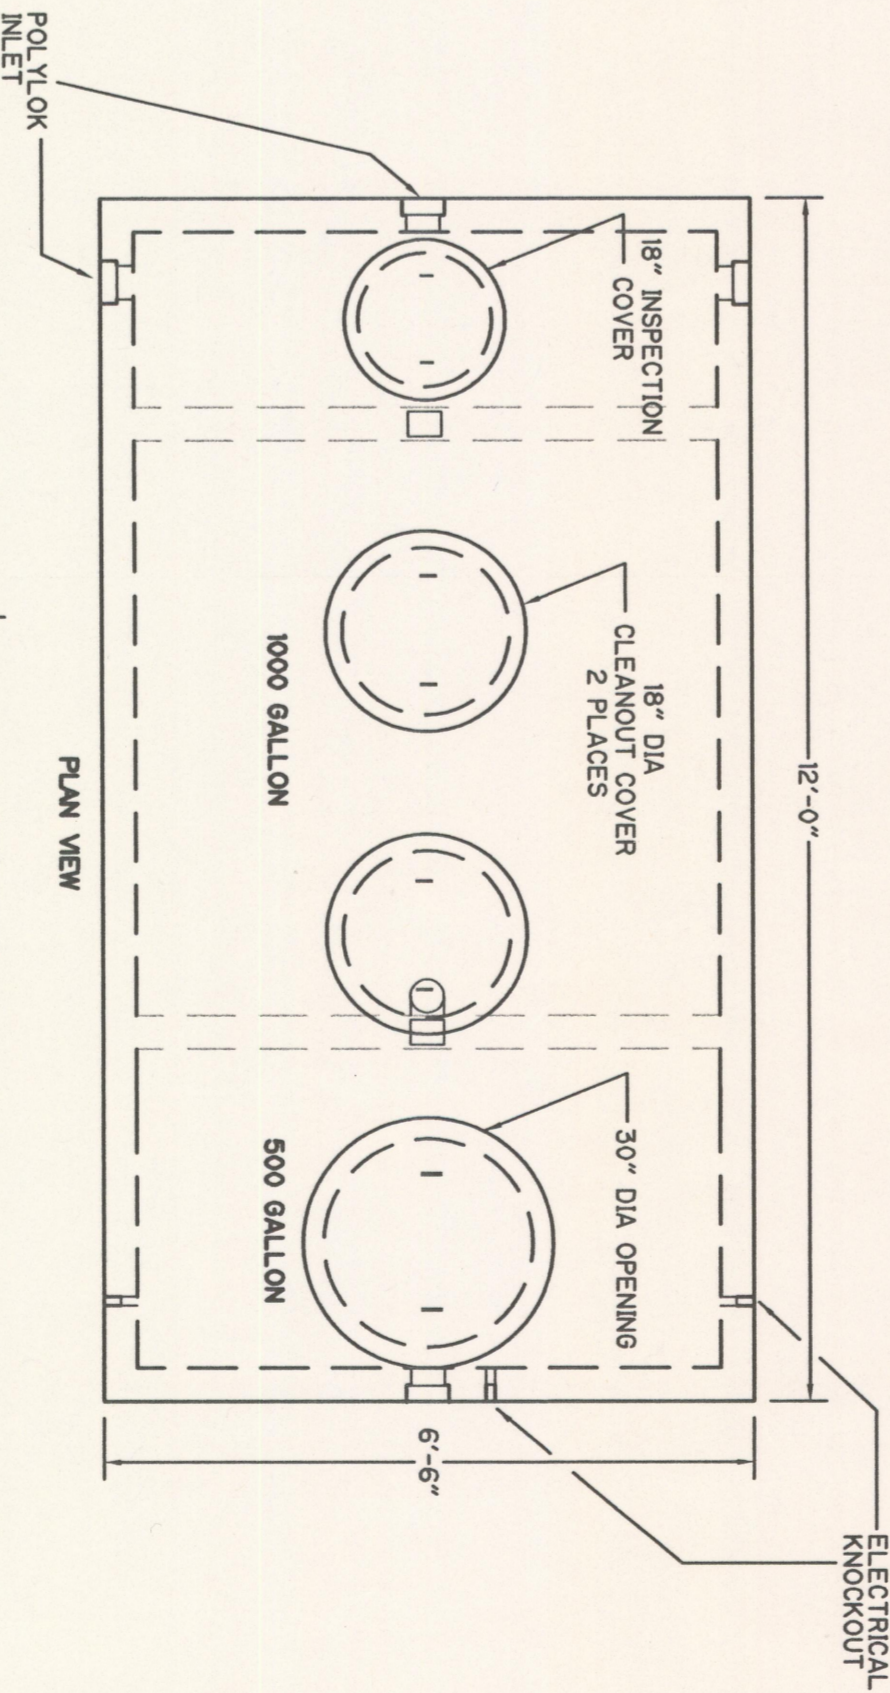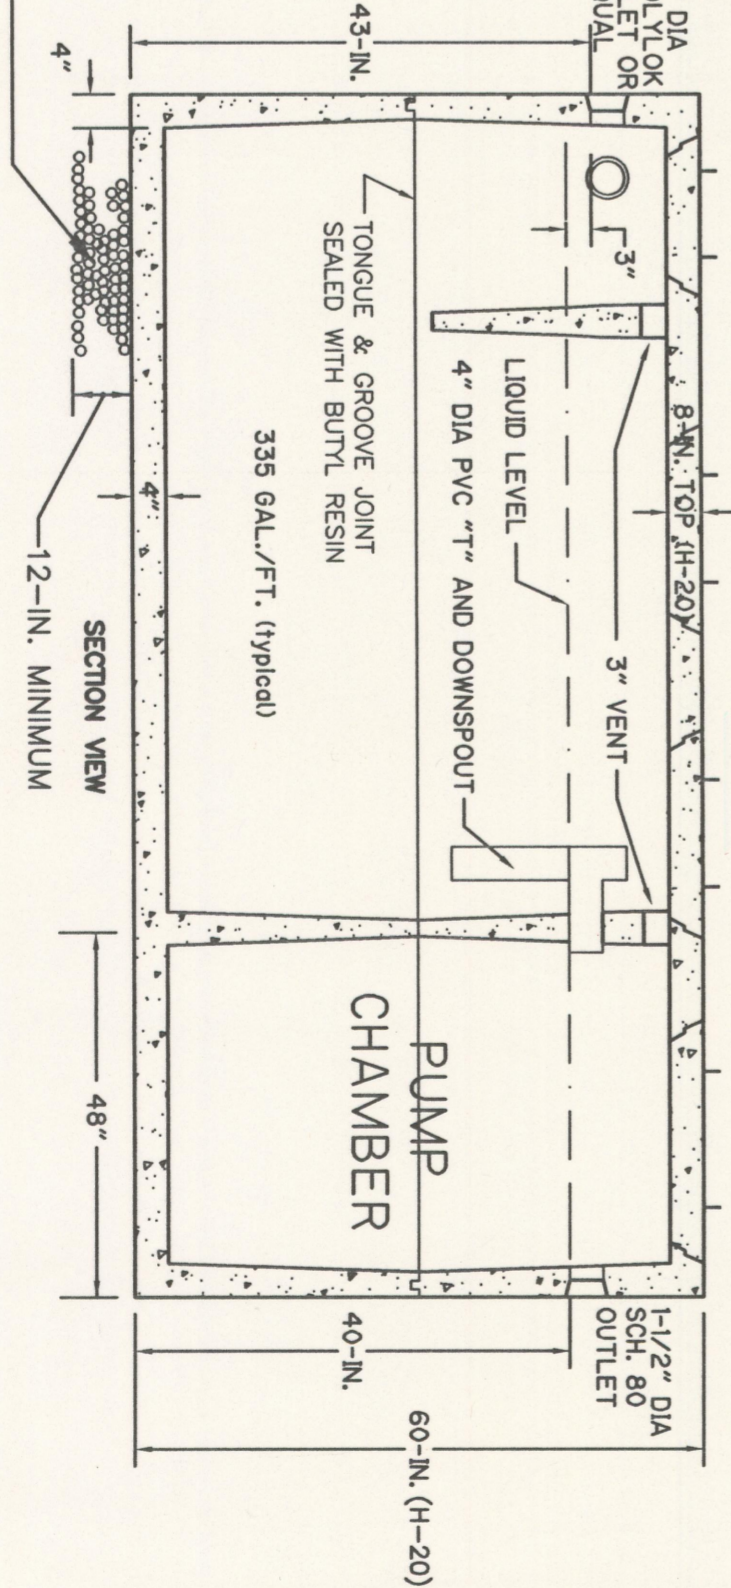

			DESIGNED BY, _____	A. ROSCOE
			DRAWN BY, _____	A. ROSCOE
			SHEET CHK'D BY, _____	P. BOROWIEC
			CROSS CHK'D BY, _____	P. BOROWIEC
			APPROVED BY, _____	
			DATE _____	APRIL 2002
REV. NO.	DATE	DRWN	CHK'D	REMARKS
0	5/3/02	ADR	PB	NOT FOR CONSTRUCTION

MTA DEPARTMENT OF TRANSPORTATION
DIVISION OF CONSTRUCTION
OFFICE OF THE ENGINEER
100 N. W. 10TH AVENUE, SUITE 200
BOZEMAN, MONTANA 59717-3300
BOZEMAN, MONTANA 59717-3300
BOZEMAN, MONTANA 59717-3300

CDM
Federal Programs Corporation
ONE CAMPUS BLVD
BOZEMAN, MONTANA 59717-3300

EPA ASBESTOS REMOVAL PROJECT
LIBBY, MONTANA

FLOOR PLANS
MILLWORK WEST
LIBBY, MONTANA
A-1

PROJECT NO. 4000-34369
FILE NAME: FLRPLANDWG
SHEET NO. A-1